

DESIGN & CONSTRUCTION GROUP THE GOVERNOR NELSON A. ROCKEFELLER EMPIRE STATE PLAZA ALBANY, NY 12242

ADDENDUM NO. 1 TO PROJECT NO. 45444

CONSTRUCTION WORK, HVAC WORK, PLUMBING WORK AND ELECTRICAL WORK PROVIDE ENCLOSED FIRING RANGE AUBURN CORRECTIONAL FACILITY, QWL SITE 3579 FRANKLIN STREET ROAD SENNETT, NY

February 13, 2019

NOTE: This Addendum forms a part of the Contract Documents. Insert it in the Project Manual. Acknowledge receipt of this Addendum in the space provided on the Bid Form.

CONSTRUCTION WORK, HVAC WORK, PLUMBING WORK AND ELECTRIC WORK SPECIFICATIONS

- 1. Page 012100 2, Change Paragraph 1.04 A. to read:
 - "A. Electrical Work Contract: Include in the contract sum the amount of \$8,879 to cover the cost of extension of three phase power along Franklin Street Road to the project site and connection of the three-phase power to the meter and transformer in coordination with New York State Electric and Gas (NYSEG) as shown on the Drawings.
 - 1. The cost of providing the Work of this allowance will be paid in the amount specified. It is a fixed price allowance. Progress payments will be determined, by the Director, by evaluating the work completed.
 - 2. Include overhead and profit for administering this allowance separately in the contract sum, not in the allowance.
 - 3. Cause the products covered by this allowance to be provided by such persons or firm and for such amount as designated.
 - 4. The amount of the allowance includes furnishing and installing the products in accordance with the requirements of referenced Specification Section(s) and Drawings.
 - 5. Execute agreement with designated persons or firm. Arrange for Samples, Shop Drawings, Product Data, Delivery and Installation in accordance with the requirements of referenced Specification Section(s) and Drawings."

- 2. Page 015000 -2, Change Paragraph 1.03 A. Items 1, 2 and 3 to Read:
 - "A. Electrical Work Contract:
 - 1. Make necessary arrangements with the local electrical utility company for the installation of a 600 ampere, 3 phase, 208-230 volt temporary electrical service to supply the needs of all contractors for the performance of their Work. Pay all utility company charges. Disconnect the service and dispose or recycle the service components at project completion.
 - 2. Provide portable source of electricity (i.e. generator) for temporary light and power of adequate capacity to supply the needs of all contractors for the performance of their Work until the 600 ampere, 3 phase, 208-230 volt temporary electrical service can be utilized for temporary light and power. Provide and pay for all fuel or other costs for the portable source.
 - 3. If a pole line is used for temporary light and power, install minimum Class 4 poles of height required to maintain at least 25 feet ground clearance under wires. Space wires on cross arms to suit voltage."
- 3. Page 015123 2, Change Paragraph 1.02 A. Item 5 a) and b) 1 through 4 to Read:
 - "5. In addition:
 - a. Provide and maintain a Cooper Atkins GL100 Data Logger Kit, at locations directed.
 - b. Provide where directed in the building, an additional 10 Cooper Atkins GL100 Temperature Data Loggers with mounts."

CONSTRUCTION WORK SPECIFICATIONS

- 4. Page 015213 3, Change Paragraph 2.01 C. Items 14 to Read:
 - "14. Provide/wire unit for phone service and internet data (Verizon Fios or Spectrum). Provide hard or internal wireless connections for three phones and internet connections for three computers. Provide three compatible phones for the connections. Pay for all installation costs, set up costs, and monthly phone and internet data service charges for the duration of the contract."
- 5. Page 015213 3, Change Paragraph 2.02 B. Items 1 and 2 to Read:
 - "1. One multifunction Printer-Scanner-Copier, HP LaserJet Pro MFP M227fdn, or equivalent. Purchase or provide one-year service agreement, paid in advance.
 - 2. Supplies for Printer-Scanner-Copier: paper, sizes as directed and toner cartridges for the duration of the project."
- 6. Page 015213 3, Change Paragraph 3.01 C. to Read:
 - "C. Provide electric service to unit from nearest available source (450' max). If a pole line is used for electrical service, install poles of height required to maintain at least 25 feet ground clearance under wires. Include 10' above grade 4x4 mast for overhead connections to trailer. Retain and pay contractor to provide electrical service, meter, and connections. Pay all utility company charges for the trailer electrical service and power for the duration of

the Contract. Disconnect the service and dispose or recycle the service components at project completion."

ELECTRICAL WORK DRAWINGS

- 7. Revised Drawings:
 - a. Drawing Nos. E-001, E-103, E-502 and E-503, noted "ADDENDUM #1" dated 02.08.2019 and Drawing No. E-106 noted "ADDENDUM #1" dated 02.11.2019 accompany this addendum and supersede the same numbered originally issued drawings.

CONSTRUCTION WORK DRAWINGS

- 8. Added Drawing:
 - a. Add the accompanying drawing numbered S-504, noted "ADDENDUM #1" dated 02.08.2019.
- 9. Revised Drawing:
 - Drawing No. S-103 noted "ADDENDUM #1" dated 02.8.2019 accompanies this addendum and supersedes the same numbered originally issued drawing.

END OF ADDENDUM

Erik T. Deyoe, P.E. Director, Division of Design Design & Construction

GENERAL NOTES

1. ALL ELECTRICAL WORK SHALL BE FURNISHED AND INSTALLED IN ACCORDANCE WITH THE 2014 EDITION OF THE NATIONAL ELECTRICAL CODE (N.E.C.), N.Y.S. BUILDING CODES AND ALL LOCAL AND MUNICIPAL CODES HAVING JURISDICTION.

- 2. VISIT SITE, ACQUAINT HIMSELF WITH EXISTING CONDITIONS AND INCLUDE ALL NECESSARY COSTS TO COMPLETE THE INSTALLATION.
- 3. FURNISH AND PAY FOR ALL PERMITS AS REQUIRED AND OBTAIN FINAL CERTIFICATE OF
- 4. WORK MUST BE COORDINATED WITH ALL OTHER TRADES TO ELIMINATE CONFLICTS AND INTERFERENCES.
- 5. BALANCE LOADS ON PARALLEL FEEDER AND ALL PANELS.
- 6. PROVIDE PROPER "FIRE STOPPING" AT ALL PENETRATIONS THROUGH FIRE RATED ASSEMBLIES. SUBMIT EXACT MATERIALS AND METHODS TO THE DIRECTOR'S REPRESENTATIVE FOR REVIEW AND APPROVAL PRIOR TO INSTALLATION. NO EXCEPTIONS
- 7. CONTROL WIRING FOR HVAC UNITS (OTHER THAN LOW VOLTAGE POWER SUPPLY WIRING) SHALL BE DONE BY HVAC CONTRACTOR.
- 8. ALL FUSES SHALL BE CURRENT LIMITING CLASS RK1.
- 9. CONDUIT AND WIRE ON POWER AND LIGHTING PLANS IS NOT SHOWN EXCEPT FOR HOMERUNS. CONTRACTOR SHALL PROVIDE ALL NECESSARY CONDUIT, BOXES, PULL BOXES, WIRING, SWITCHES AND ACCESSORIES TO INTERCONNECT THE ELECTRICAL ITEM FOR CIRCUITING AND HOMERUNS INDICATED SYMBOLICALLY ON THE DRAWINGS. SEE LEGEND-HOMERUNS DESIGNATION FOR SYMBOLOGY APPLICABLE TO ALL SYMBOLS SHOWN.
- 10. TO PROVIDE ALL WALL BOXES FOR POWER & VOICE/DATA. E.C. MUST PROVIDE POWER WHIP, VOICE/DATA RACEWAYS AND FINAL POWER CONNECTIONS TO FURNITURE SYSTEMS. FINAL COORDINATION WITH FURNITURE VENDOR IS THE RESPONSIBILITY OF THE
- 11. PROVIDE ALL TEMPORARY INTERIOR LIGHTING FOR ALL TRADES DURING DEMOLITION (IF APPLICABLE) & CONSTRUCTION.
- 12. POWER DISTRIBUTION NOTE: CONDUITS TO BE AS FOLLOWS. WHERE RUN WITHIN THE BUILDING IN DRY LOCATIONS NOT SUBJECT TO PHYSICAL DAMAGE PROVIDE E.M.T. WHERE RUN IN BUILDING WHERE SUBJECT TO PHYSICAL DAMAGE, WET OR DAMP LOCATIONS, THRU ROOFS OR CONCRETE PROVIDE THICK WALLED RIGID STEEL CONDUIT. WHERE RUN UNDERGROUND PROVIDE SCHEDULE 80 P.V.C. EXCEPT THAT ALL ELBOWS ON P.V.C. CONDUIT SYSTEM SHALL BE THICK WALLED RIGID STEEL AND SHALL BE GROUNDED IN ACCORDANCE WITH N.E.C. 300-5(D) WHERE REQUIRED.

TYPICAL DEVICE MOUNTING HEIGHT RECEPTACIES (OFFICE AREA).

	RECEPTACLES (OFFICE AREA) ——————	–18" AFF
	RECEPTACLES (U.O.N.)	–36" AFF
	LIGHT SWITCHES —	– 48" AFF
	DISCONNECT SWITCHES —	-NEC 240.24
	TELEPHONE OUTLETS -	-18" AFF
	TELEPHONE OUTLET (WALL MTD)	– 48" AFF
	COMPUTER OUTLETS —	–18" AFF
	CLOCK OUTLETS	-7'-6" AFF
	FIRE ALARM PULL STATION —	– 48" AFF
	FIRE ALARM AUDIO/VISUAL ALARM	-80" AFF
	EXIT LIGHTS (WALL MTD)	-1' ABOVE DOOR
	EMERGENCY LIGHTS (WALL MTD) —	-7'-6" AFF
	TV OUTLETS	–18" AFF
	AUDIO/VIDEO OUTLETS —	–18" AFF
	MICROPHONE OUTLETS —	–18" AFF
	PA ANNUNCIATOR PANEL	– 48" AFF
	WELDING OUTLETS —	
	NOTE: DIMENSIONS ARE TO DEVICE CENTER UNLESS NOTED OTHERWISE	<u>LINE</u>
_		· · · · · · · · · · · · · · · · · · ·

ABBREVIATIONS

KILOVOLT AMPERE

MAIN LUGS ONLY

MAIN CIRCUIT BREAKER

NATIONAL ELECTRICAL

NOT IN CONTRACT

WP WEATHERPROOF (NEMA 3R)

U.O.N. UNLESS OTHERWISE

NATIONAL ELECTRICAL CODE

MANUFACTURERS ASSOCIATION

NOTED

UH UNIT HEATER

XFMR TRANSFORMER

- 1				
	Α	AMP-AMPERE	KVA	KILOVOLT AMPERI
	AFF	ABOVE FINISHED FLOOR	KW	KILOWATT
	AWG	AMERICAN WIRE GAUGE	KWH	KILOWATT HOUR
	BKR	BREAKER	LP	LIGHTING PANEL
	С	CONDUIT/CONDUCTOR	LTG	LIGHTING
	CB	CIRCUIT BREAKER	MANUF	MANUFACTURER
	CKT	CIRCUIT	MC	MAIN CIRCUIT BR
	CU	COPPER	MLO	MAIN LUGS ONLY
	DWG	DRAWING	N NEC	NEUTRAL NATIONAL ELECTF
	E.C.	ELECTRICAL CONTRACTOR		
	ELEC	ELECTRICAL	NEMA	NATIONAL ELECTI MANUFACTURERS
	EF	EXHAUST FAN	NIC	NOT IN CONTRAC
	FACP	FIRE ALARM CONTROL PANEL	PNL	PANEL
	G	GROUND	RTU	ROOF TOP UNIT
	GFI	GROUND FAULT INTERRUPT	TYP	TYPICAL
	LID	HARCEDAWER	1.15	IIIIOAL

HP HORSEPOWER

KV KILOVOLT

H.C. HVAC CONTRACTOR

VAV VARIABLE AIR VOLUME

THIS SYMBOL LEGEND IS SHOWN FOR GENERAL REFERENCE ONLY. THE PRESENCE OF A SYMBOL ON THIS LEGEND DOES NOT IMPLY ITS USE ON THIS PROJECT. REFER TO DRAWINGS FOR SPECIFIC SYMBOLS USED.

FOR EACH HOMERUN; NOT SHOWN.

E-EXPOSED

JUNCTION BOX

PANELBOARD, SURFACE MOUNTED

RECEPTACLE, DUPLEX EM = EMERGENCY

WP = WEATHERPROF, NEMA 3R

Ψ RECEPTACLE, SPECIAL PURPOSE

A = 120V, 20A, 1 PHASE, 2-POLE, 3W, NEMA 5-20R. B = 208V, 20A, 1 PHASE, 2-POLE, 3W, NEMA 6-20R. C = 120V, 30A, 1 PHASE, 2-POLE, 3W, NEMA 5-30R. D = 208V, 30A, 1 PHASE, 2-POLE, 3W, NEMA 6-30R. E = 208V, 60A, 1 PHASE, 3-POLE, 4W, NEMA 14-60R.

☑ ENCLOSED CIRCUIT BREAKER

D' DISCONNECT SWITCH, FUSED ☐ DISCONNECT SWITCH, UNFUSED STARTER, COMBINATION WITH

DISCONNECT SWITCH (NIC) STARTER OR MOTOR CONTROLLER (NIC)

/ SWITCH SIZE 30 3 - NUMBER OF 20 POLES FUSE/BREAKER SIZE BLANK DENOTES UNFUSED

 2 BLANK = SINGLE POLE L = LOCK 2 = DOUBLE POLE 3 = THREE-WAY

M = MOTOR4 = FOUR-WAYD = DIMMERF = FUSEDK = KEY OPERATED 3R

(c) CEILING MOUNTED OCCUPANCY SENSOR.

—UGC— UNDERGROUND COMMUNICATION CONDUIT — OH — OVERHEAD POWER LINE

BATTERY OR EMERGENCY (LIFE SAFETY) GENERATOR POWER.

COMBINATION EMERGENCY AND EXIT SIGN.

∇ ▼ ▼ DATA; VOICE/DATA; VOICE

OUTLÉT CR CARD READER

REFER TO SUPPLEMENTAL FIGURE INDICATED BY NUMBER (I.E. F2 REFERS TO FIGURE 2)

XXX DETAIL TAG/CALL OUT TAG

TRANSIENT VOLTAGE

VARIABLE FREQUENCY DRIVE

MAGNETIC DOOR SWITCH DS PANIC BUTTON

CEILING MOUNTED SECURITY MOTION SENSOR.

ELECTRICAL SYMBOL LEGEND

BRANCH CIRCUIT HOMERUN. SHORT LINES INDICATE PHASE CONDUCTORS. LONG LINES INDICATE NEUTRAL CONDUCTOR. ONE SEPARATE GREEN GROUNDING CONDUCTOR SHALL BE PROVIDED

C-CONCEALED

PANELBOARD, RECESSED

GFI = GROUND FAULT INTERRUPTER


RECEPTACLE, QUADRUPLEX

RECEPTACLE, SINGLE

F = 208V, 30A, 3 PHASE, 3-POLE, 4W, NEMA 15-30R. G = 208V, 50A, 3 PHASE, 3-POLE, 4W, NEMA 15-30R. H = 208V, 60A, 3 PHASE, 3-POLE, 4W, NEMA 15-60R.

DISCONNECT/CB TAG □ VARIABLE FREQUENCT DRIVE (NIC)

OS = OCCUPANCY SENSORP = WITH PILOT LIGHTT = TIMER OPERATEDWP = WEATHER PROOF, NEMA LV = LOW VOLTAGE X = EXPLOSION PROOF

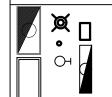

LIGHT FIXTURES, VARIOUS. SEE LIGHTING FIXTURE SCHEDULE. DARK BLACK HATCH INDICATES EMERGENCY

EXIT SIGN, CEILING MOUNTED; EXIT SIGN, WALL MOUNTED. ARROWS INDICATE CHEVRON

/#/ MOTOR, # = HORSEPOWER (NIC)

XXX ← EQUIPMENT TAG EQUIPMENT NUMBER

V-XXX €LECTRICAL SHEET NUMBER

SURGE SUPPRESSOR RANGE CONTROL PANEL(NIC) RANGE VENTILATION CONTROL PANEL(NIC)

REMOTE START/STOP STATION FILTER STATUS PANEL (NIC)

ELECTRIC DOOR STRIKE

BUILDING MANAGEMENT SYSTEM (NIC)

NEW YORK Office of **General Services**

DESIGN & CONSTRUCTION

CONSULTANT



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PROVIDE ENCLOSED FIRING RANGE QWL SITE

AUBURN CORRECTIONAL FACILITY QWL SITE | 3579 FRANKLIN STREET ROAD

SENNETT, NY

DEPARTMENT OF CORRECTIONS AND COMMUNITY SUPERVISION

02/08/2019 ADDENDUM #1 10/15/2018 | FINAL SUBMISSION 100% SUBMISSION 5/04/2018 65% SCHEMATIC 1/18/2018 DESCRIPTION PROJECT

45444 -NUMBER: DESIGNED BY: P. BELAVUS DRAWN BY: P. BELAVUS FIELD CHECK: APPROVED: R. BLANCH

ELECTRICAL NOTES, SYMBOLS & LEGENDS

DRAWING NUMBER:

SHEET TITLE:

DESIGN & CONSTRUCTION

NEW YORK STATE OF OFFICE OF General Services

CONSULTANT



LiRo Engineers, Inc.
3 Aerial Way, Syosset, New York

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DEPARTMENT OF CORRECTIONS AND COMMUNITY SUPERVISION

\triangle	02/08/2019	ADDENDUM #1	
	10/15/2018	FINAL SUBMISSION	
	5/04/2018	100% SUBMISSION	
	1/18/2018	65% SCHEMATIC	
MARK	DATE	DESCRIPTION	
PROJECT NUMBER:	45444 — E		
DESIGNED BY:	P	RFI AVIS	

DRAWN BY: P. BELAVUS FIELD CHECK: APPROVED: R. BLANCH SHEET TITLE:


> ADDENDUM #1 ELECTRICAL FLOOR PLAN-LIGHTING

DRAWING NUMBER:

E - 103SHEET 80 OF 91

ELECTRICAL NOTES:


THERE IS A SECURITY VIOLATION AND CEASE-FIRE, A GREEN LIGHT FOR A COLD RANGE AND AN AMBER LIGHT FOR RANGE IN USE. 2 PROVIDE IN-USE SIGN (EDWARDS-SIGNALS 200 CLASS OR EQUAL) WITH THREE LIGHT COLORS. ONE FLASHING RED LIGHT, ONE GREEN LIGHT AND ONE AMBER LIGHT. EACH INDIVIDUALLY CONTROLLED BY RELAY. 3 WIRE LIGHTS THROUGH PHOTOCELL LOCATED ON ROOF.

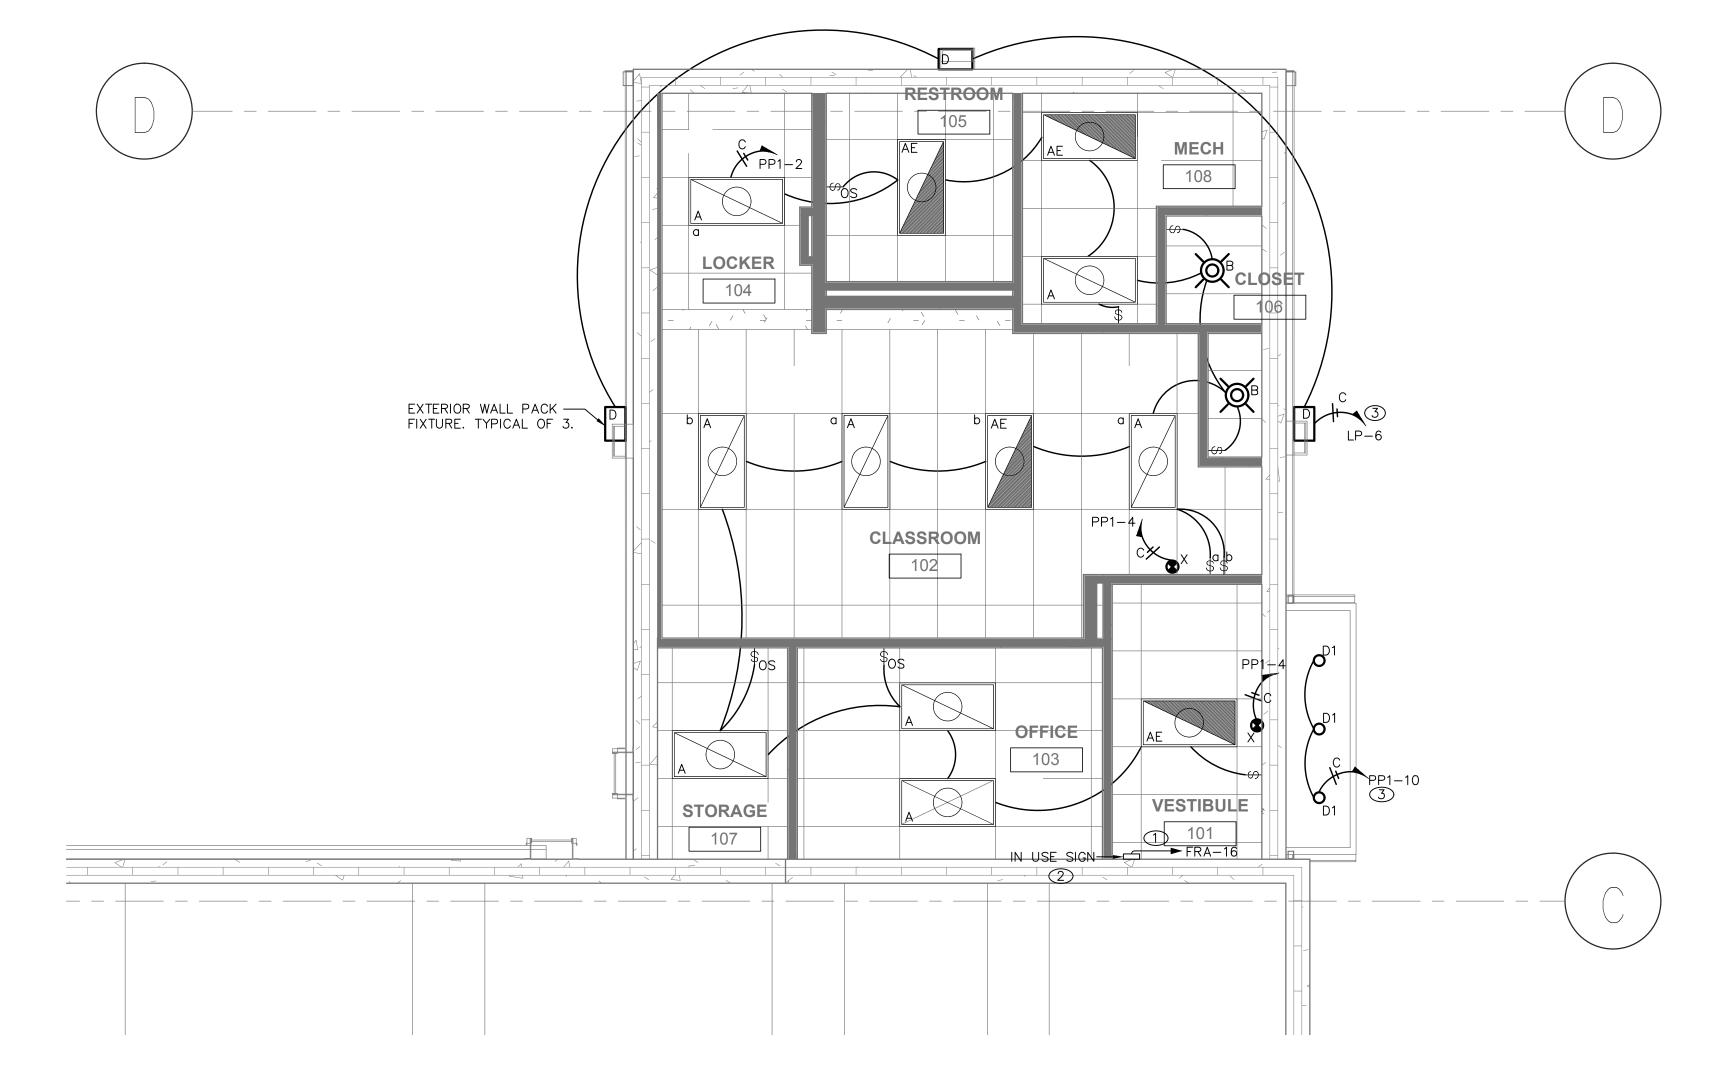


 $\underbrace{\frac{1}{E-103}}_{\text{SCALE: } 1/4" = 1'-0"} \underbrace{\text{ELECTRICAL FLOOR PLAN-LIGHTING}}_{\text{SCALE: } 1/4" = 1'-0"}$

	LIGHTING FIXTURE SCHEDULE								
ID	MANUFACTURE	DESCRIPTION	MODEL	VOLTAGE		LAMPS	-	FIXTURE	COMMENTS
					LUMENS	TYPE	COLOR TEMP	WATTAGE	
А	COOPER	2x4 LED	2ALNG-LD1-45-UNV-L835-CD1-U	120V	4500	LED	3500K	45	PROVIDE BACKUP BATTERY FOR "AE" FIXTURES. FULL LUMENS FOR 90 MIN.
В	HALO	6" DOWNLIGHT	H750TD010-ML712827TUNVD010-494WB06	120V	-	LED	3000K	18	-
D	ENERTRON	WALL PACK	490LED4X12S-50	120 V	4480	LED	4000K	32	-
D1	HALO	4" ROUND LED ADJUSTABLE GIMBLE	RL460WH835PK	120 V	880	LED	3500K	13	-
х	EXITRONIX	EXIT LIGHT	XL 600 SERIES	120 V	-	LED	-	1	-
PLL-1	McGRAW EDISON	SITE LIGHT	GLEON-AF-02-LED-E1-T2-BZ	120V	-	LED	4000K	150	PROVIDE 20 FOOT POLE

SCHEDULE NOTE: ALL ELECTRICAL LIGHTING FIXTURES ARE SUBJECT TO ARCHITECTURAL APPROVAL PRIOR TO PURCHASE

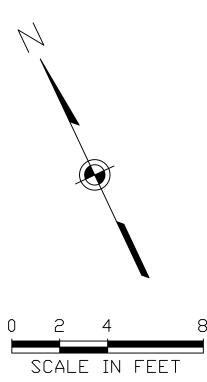

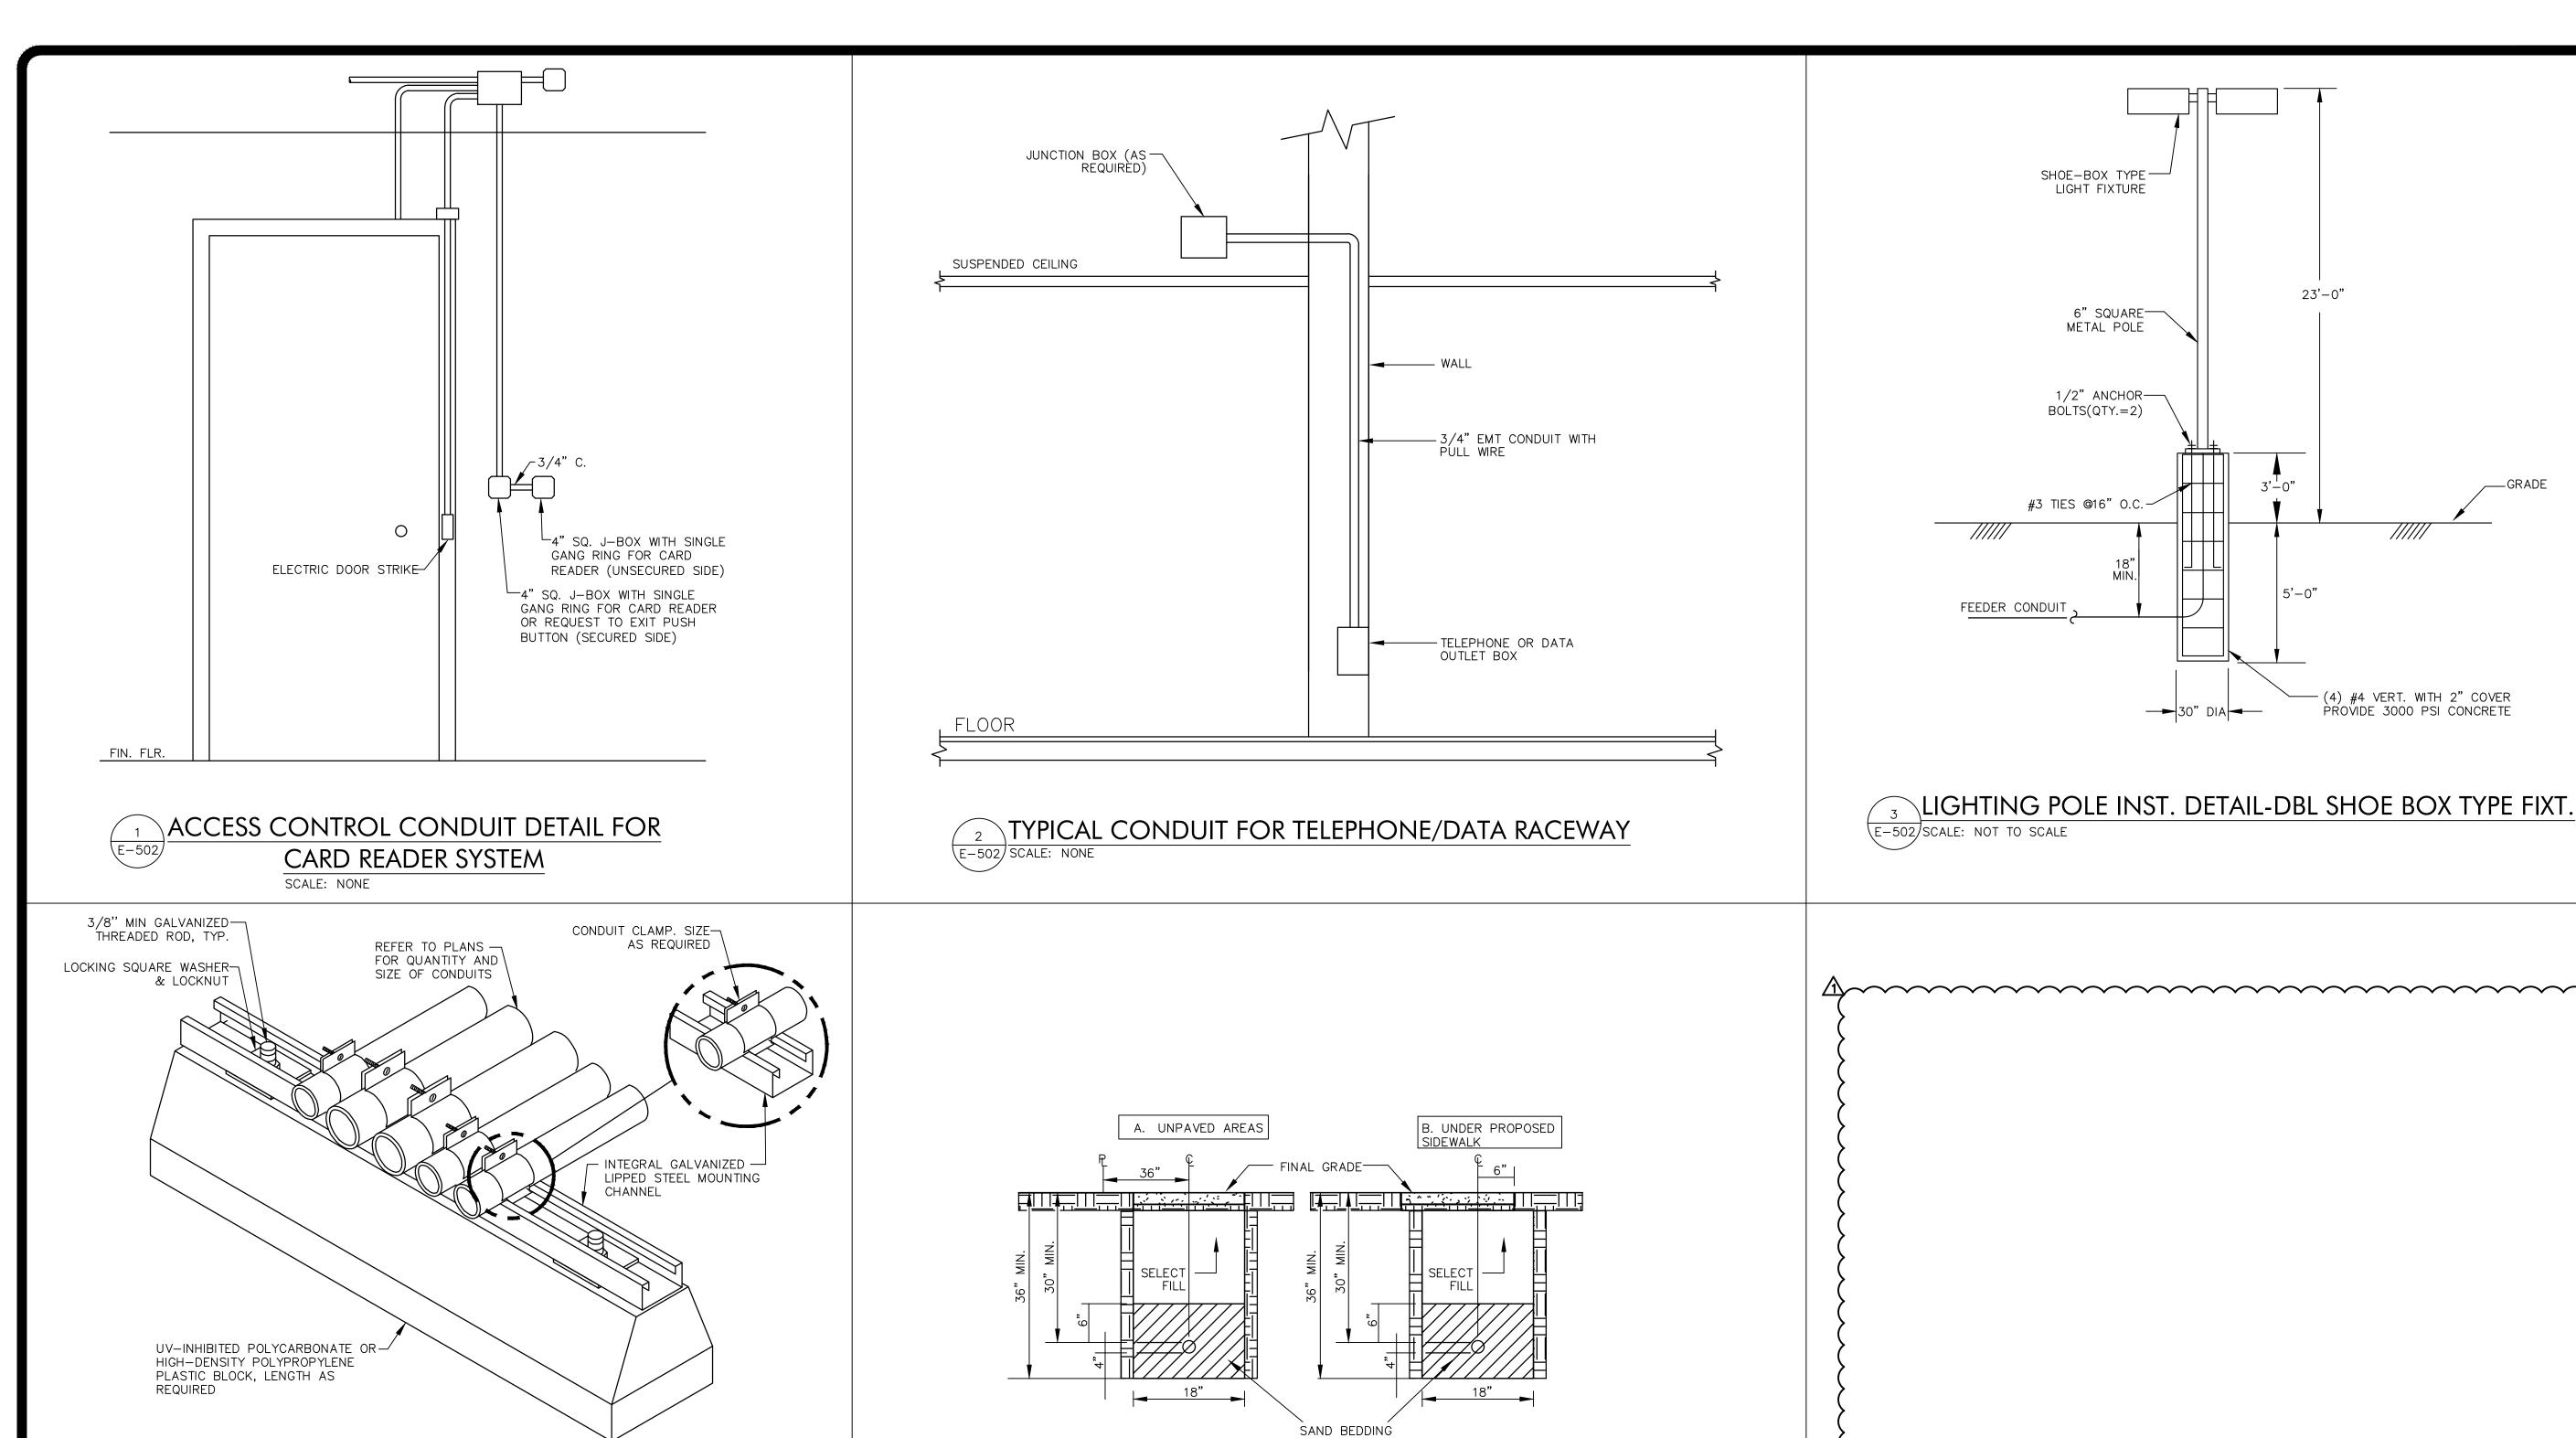

. ADJACENT TO EXISTING SIDEWALKS

A" = MIDPOINT

E-502 SCALE: NONE

PROP- ERTY LINE

BETWEEN SIDEWALK &

EXISTING -

SIDEWALK

(WHERE

RÈQUIRED)

SAND BEDDING

(WHERE

RÈQUIRED)

5 INSTALLATION OF UNDERGROUND CONDUITS

D. UNDER PAVED SURFACES,

DRIVEWAYS, ETC. (PROPOSED OR


FINAL GRADE


SELECT FILL


- PVC CONDUIT SIZE AND QUANTITY AS

ROADS, PARKING LOTS

EXISTING)

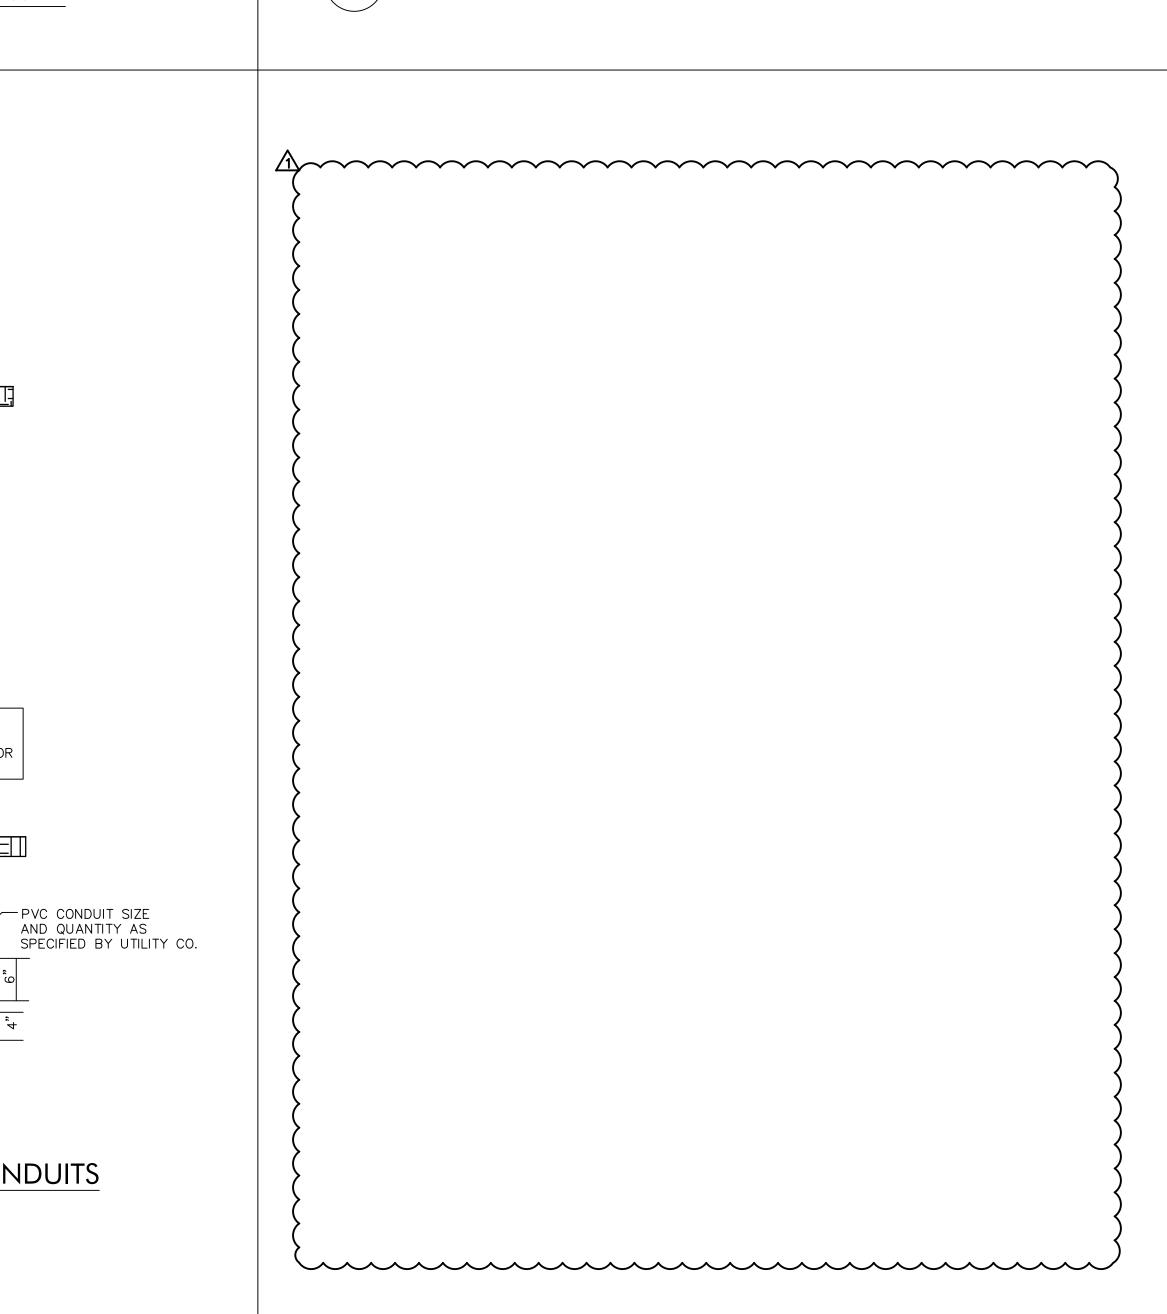

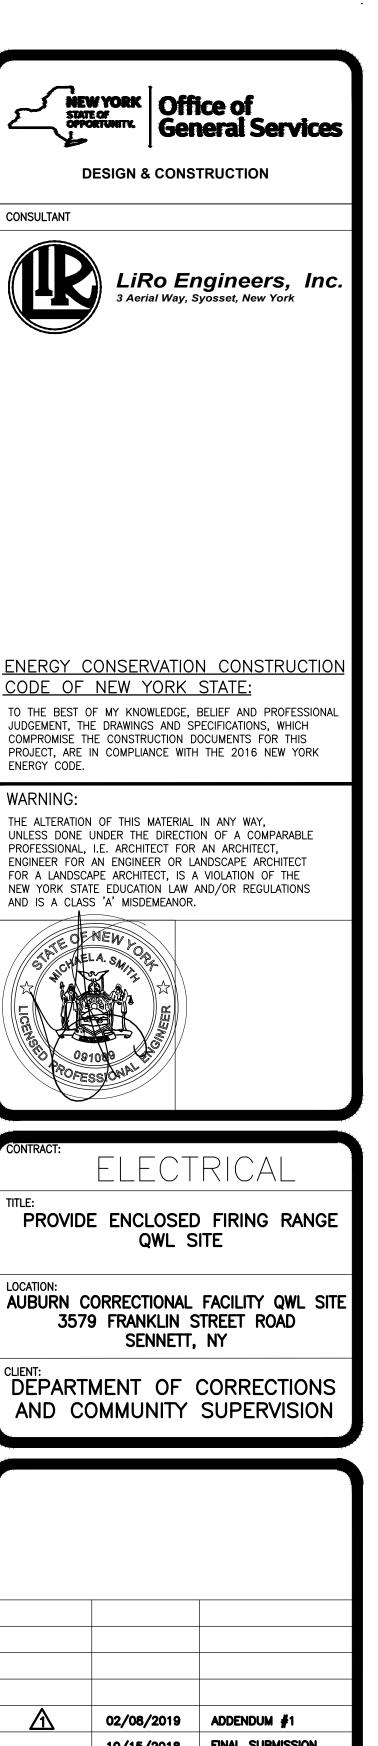

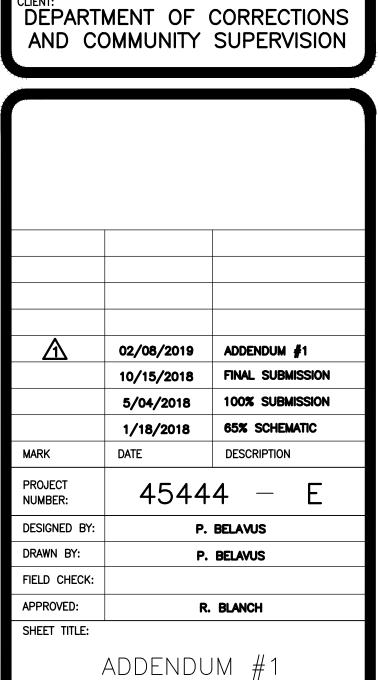

COVER

ROOF CONDUIT SUPPORT DETAIL

- SKID RESISTANT

SURFACE

25mm (1") DEEP (MIN.).

100mm (4") MOUSEHOLES (4)

E-502 SCALE: NONE

7 HANDHOLE DETAIL

- 10mm (3/8") STAINLESS STEEL

HEX HEAD BOLT WITH WASHER

— 15mm (1/2") X 100mm (4") PULL SLOT


<u>EXFENSION</u>


1. PROVIDE NYSEG STANDARD 13"W X 24"L X 18"D HANDHOLE. ELECTRICAL CONTRACTOR TO COORDINATE ALL REQUIREMENTS WITH NYSEG.

E-502 SCALE: NONE

DRAWING NUMBER: E - 502

ELECTRICAL DETAILS

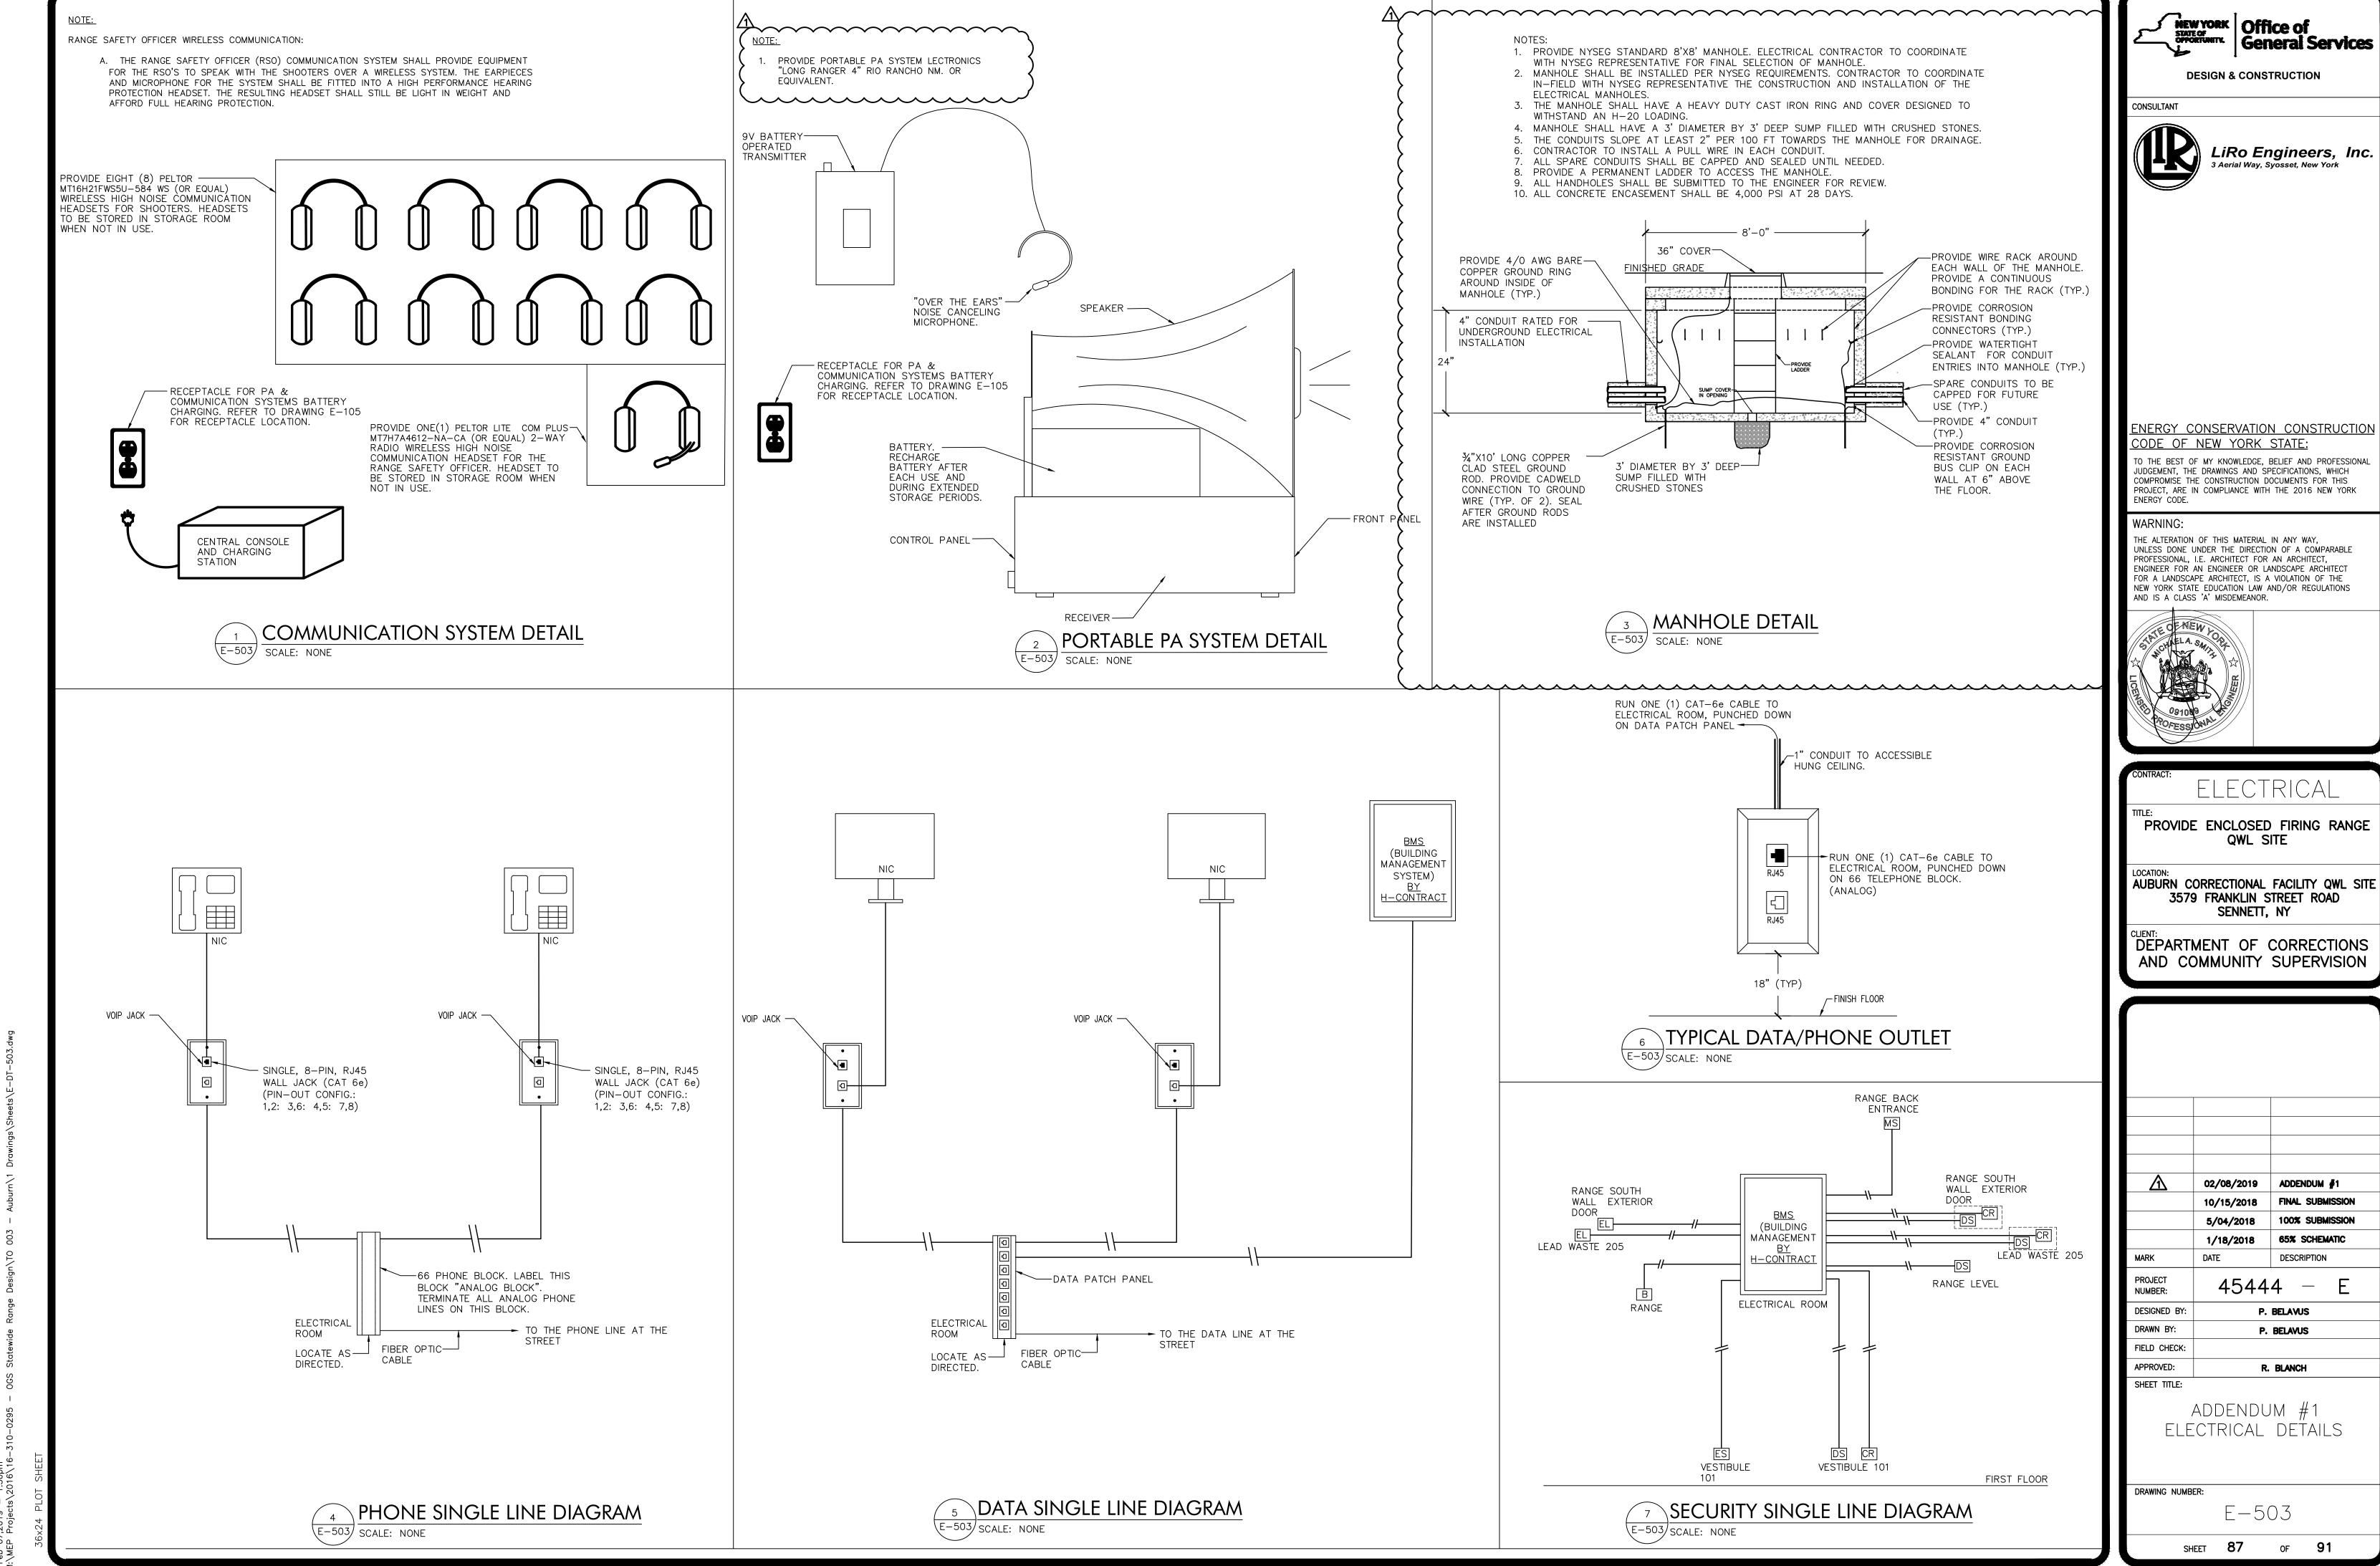

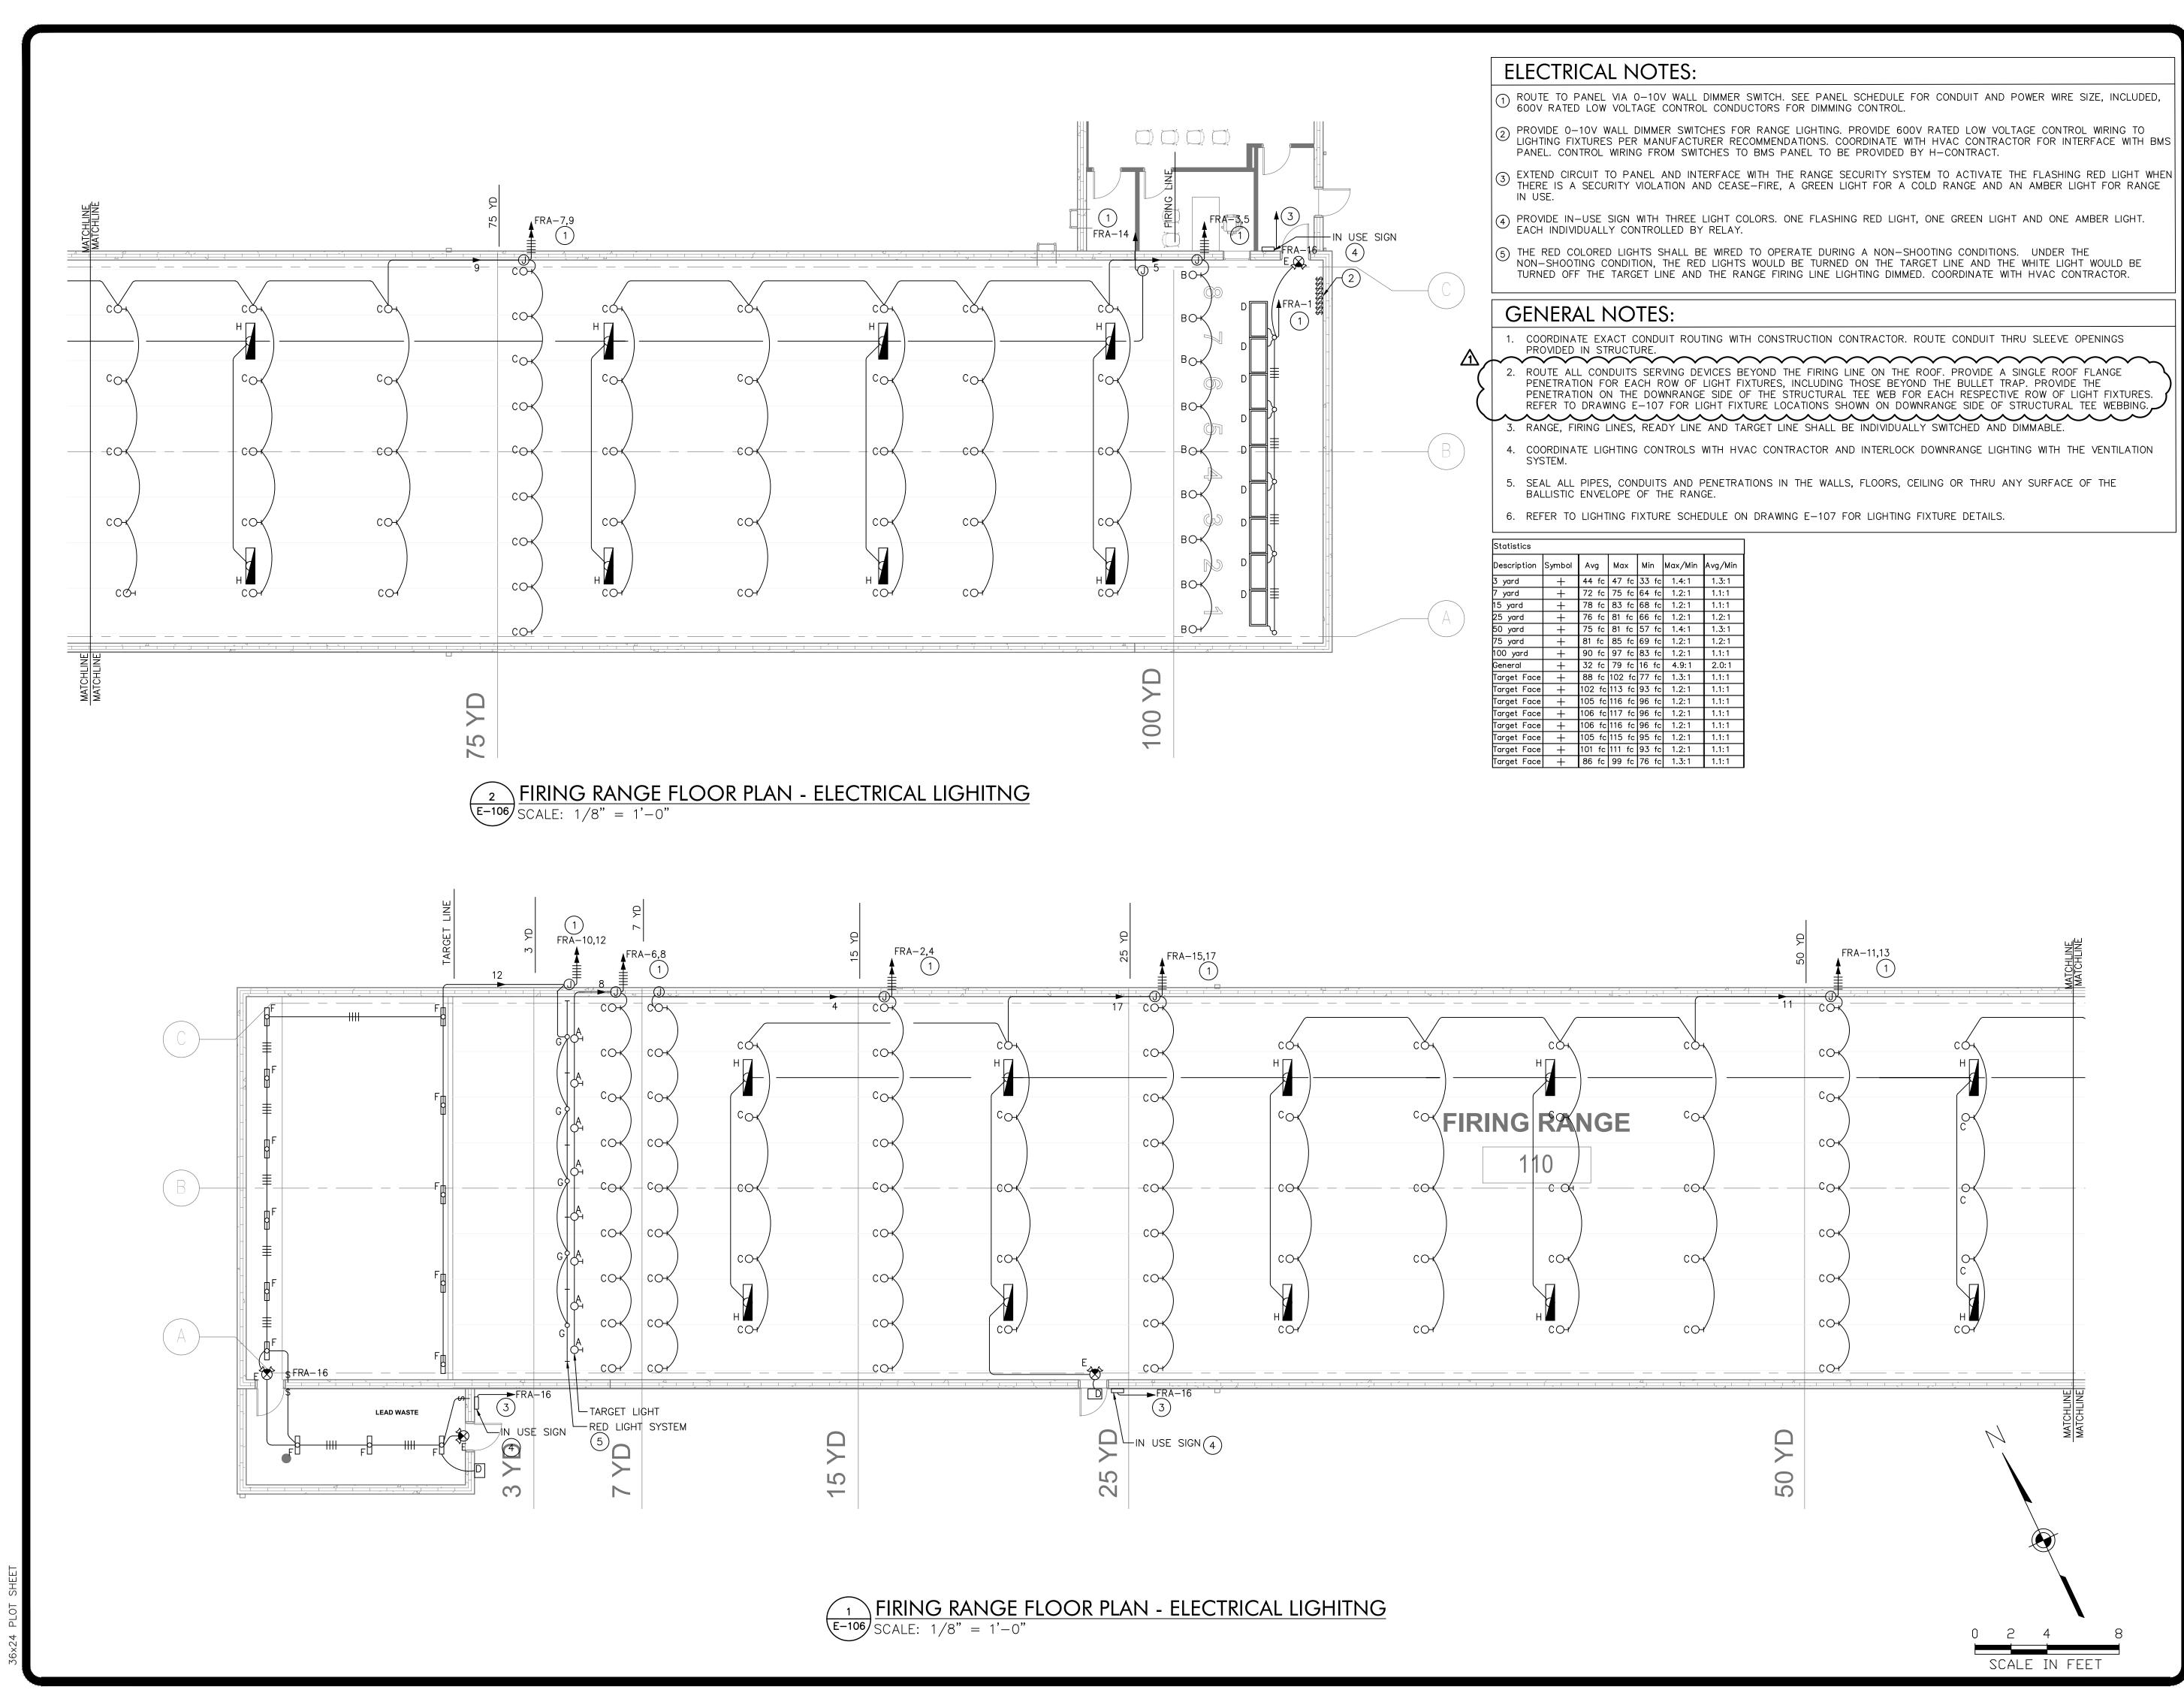

NEW YORK Office of STATE OF GENERAL SERVICE OF GENE **General Services**

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PROVIDE ENCLOSED FIRING RANGE

QWL SITE

AUBURN CORRECTIONAL FACILITY QWL SITE 3579 FRANKLIN STREET ROAD SENNETT, NY


DEPARTMENT OF CORRECTIONS AND COMMUNITY SUPERVISION

\triangle	02/11/2019	ADDENDUM #1				
	10/15/2018	FINAL SUBMISSION				
	5/04/2018	100% SUBMISSION				
	1/18/2018	65% SCHEMATIC				
ARK	DATE	DESCRIPTION				
ROJECT UMBER:	45444 — E					
ESIGNED BY:	P. BELAVUS					
RAWN BY:	P. BELAVUS					
ELD CHECK:						
PPROVED:	ROVED: R. BLANCH					
HEET TITLE:						
IRING	RANGE F	FLOOR PLAN				
		LICHTING				

- ELECTRICAL LIGHTING

DRAWING NUMBER:

E - 106

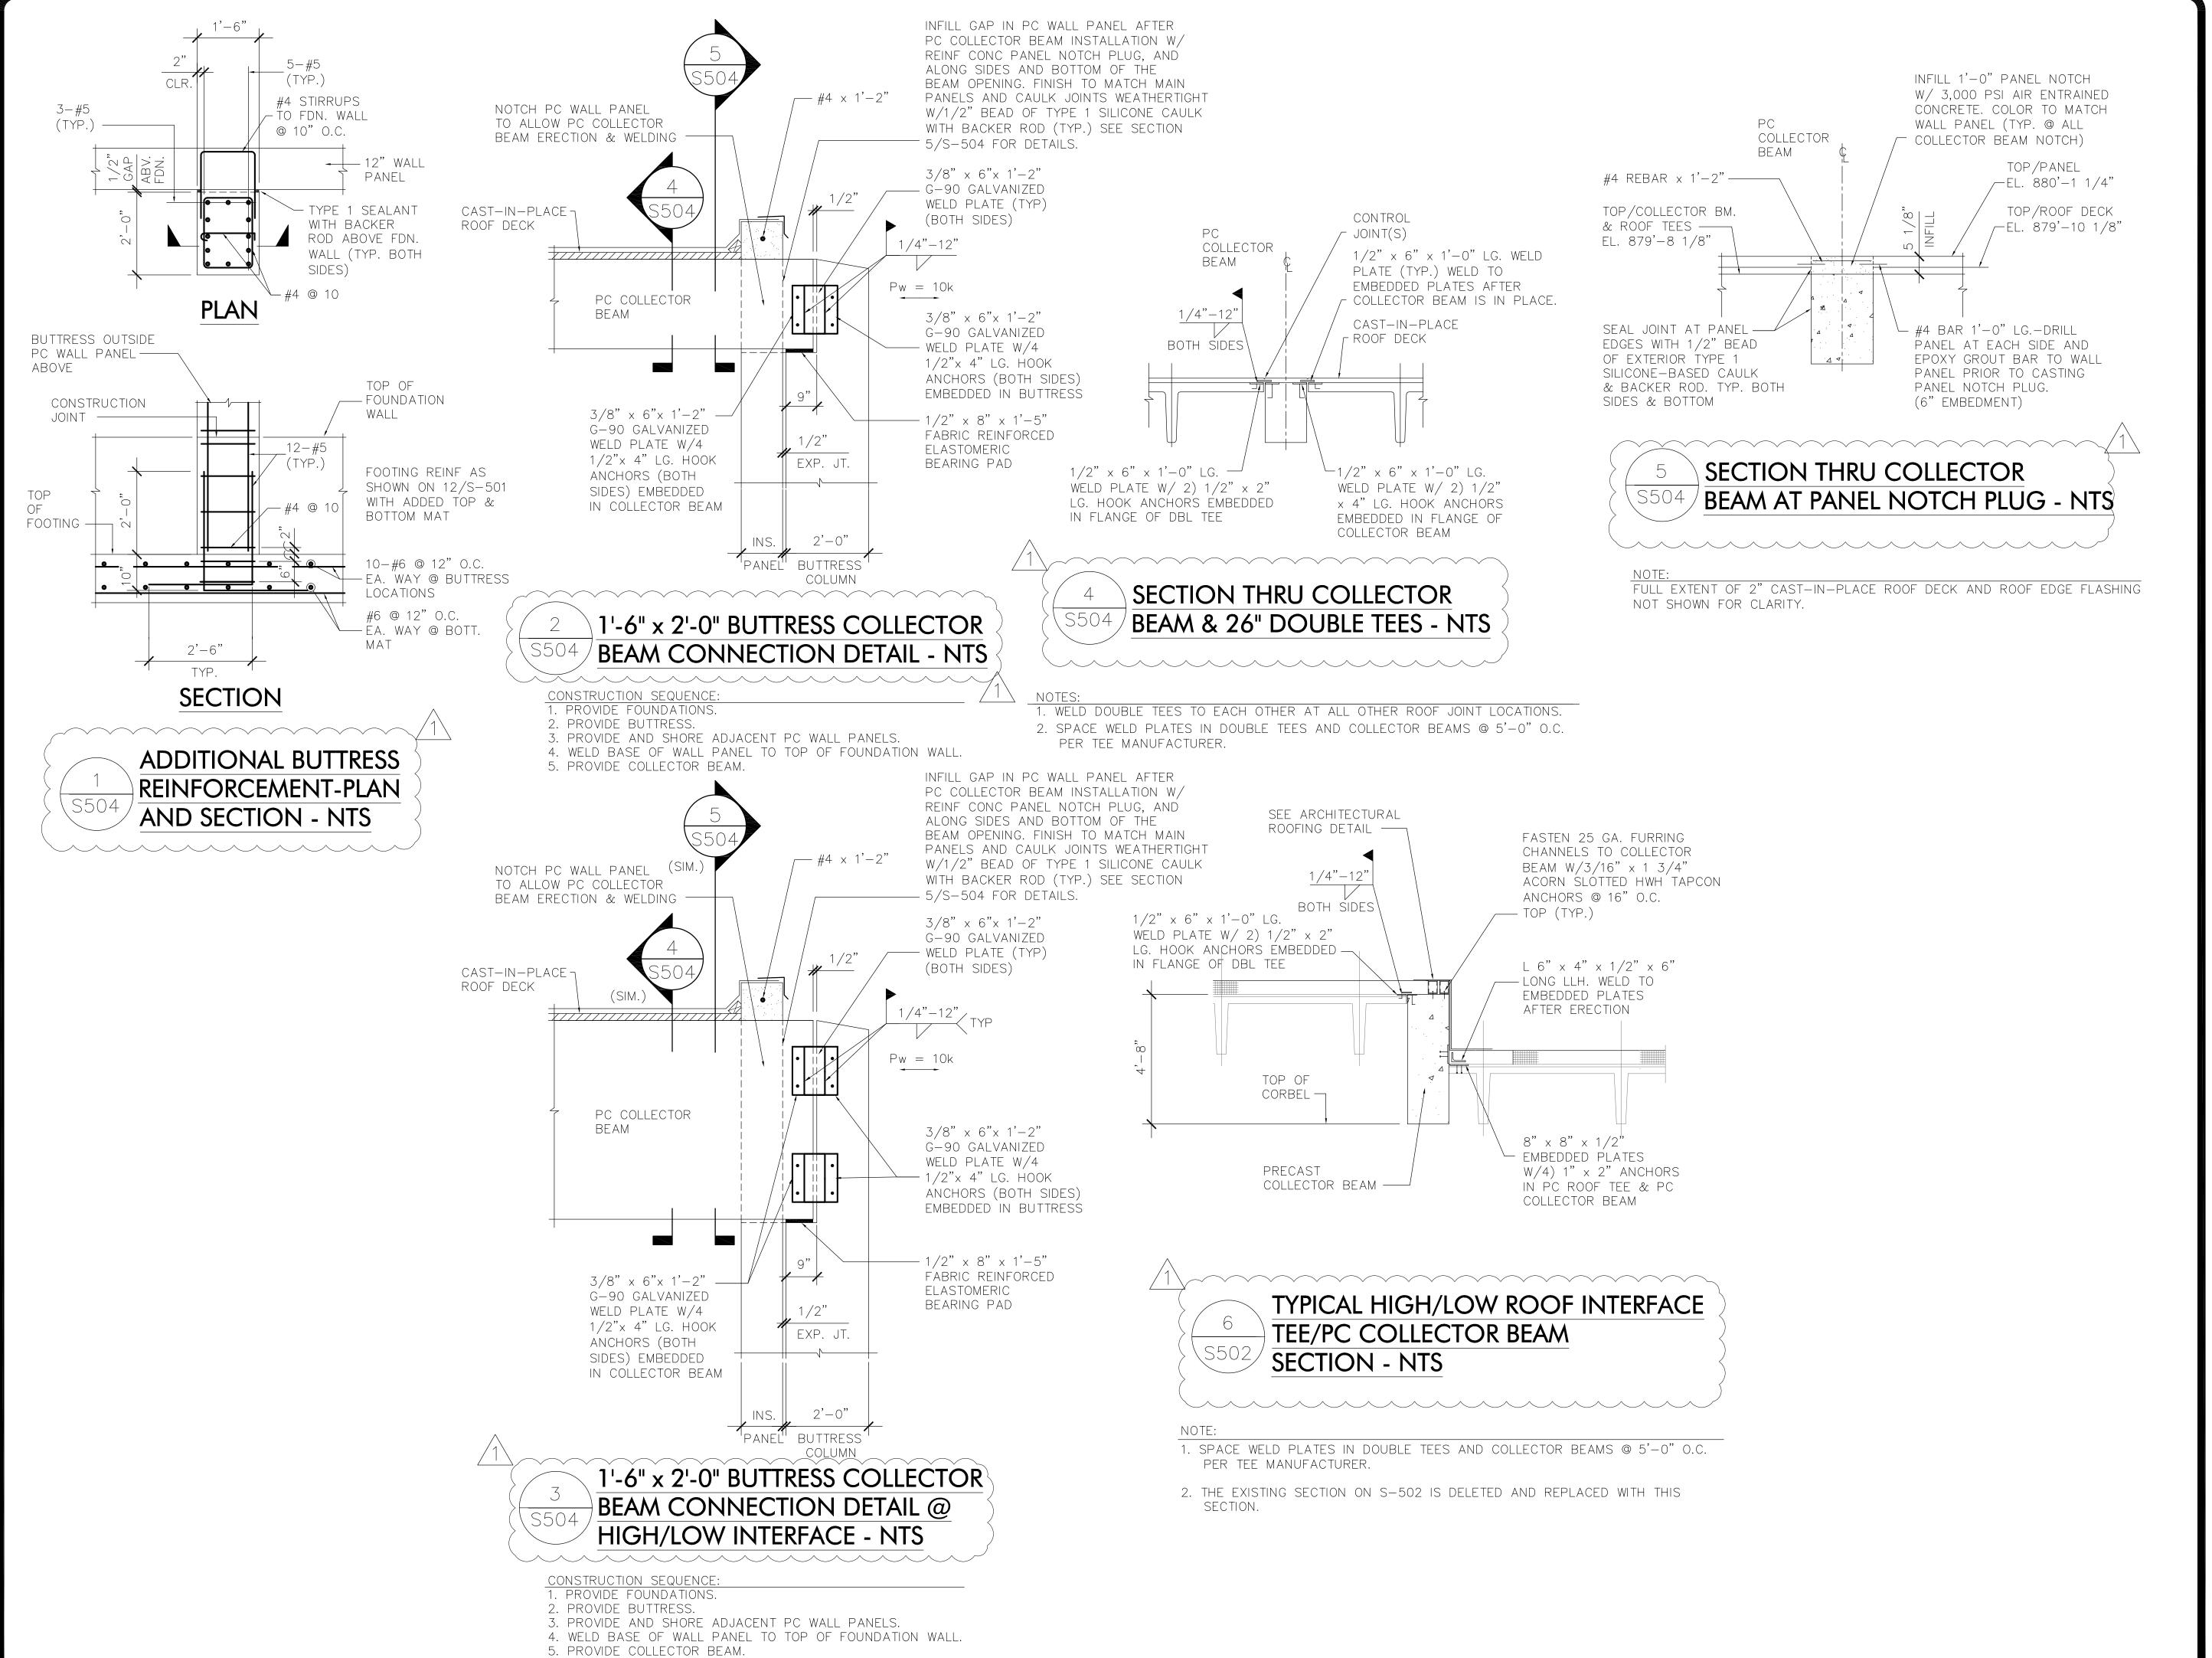

NEW YORK STATE OF OPPORTUNITY. General Services **DESIGN & CONSTRUCTION** CONSULTANT

LiRo Engineers, Inc.

ENERGY CONSERVATION CONSTRUCTION CODE OF NEW YORK STATE:

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PROVIDE ENCLOSED FIRING RANGE QWL SITE

AUBURN CORRECTIONAL FACILITY QWL SITE 3579 FRANKLIN STREET ROAD SENNETT, NEW YORK

DEPARTMENT OF CORRECTIONS AND COMMUNITY SUPERVISION

2/8/2019 ADDENDUM #1 DESCRIPTION **PROJECT** 45444 ___ NUMBER: DESIGNED BY B. HUTTEMAN DRAWN BY:

J. KOHLER FIELD CHECK:

APPROVED: SHEET TITLE:

> ADDENDUM #1 STRUCTURAL DETAILS

DRAWING NUMBER:

S - 504

